2006

**IECC** 

APPROVAL IS SUBJECT TO FIELD

INSPECTION AND COMPLIANCE

WITH ALL RELEVANT CODES,

LAWS AND ORDINANCES

THE ENGINEERED GEOTECHNICAL REPOR

WITH THE PERMITTED PLANS.

DOUBLE CARPORT

-TYP. 6  $\times$  6 POST

1-800-782-5348 YAVAPAI COUNTY

# Single-Family Housing Two Bedroom / Two Bath

YAVAPAI COUNTY To avoid construction delays and added construction
Contact APS BEFORE you start construction;
APS Prescott Office: 928-443-6797; Prescottcontroldesk@ap
APS Cottonwood Office: 928-646-8502; Verdecontroldesk@a
APS Wickenburg Office: 602-371-6200; Wickenburgcontroldesk@ap Prescott, Arizona

YAVAPAI COUNTY BUILDING DEPT. ( ) REVIEWED FOR CODE COMPLIANCE



WINDOW OR EXTERIOR DOOR APPROVED FOR RESCUE FOR EVERY ROOM USED FOR SLEEPING

## OF INSPECTION

### INDEX TO DRAWINGS

FLOOR PLAN / SCHEDULES ALTERNATE GARAGE PLAN

FOUNDATION PLAN / ROOF FRAMING PLAN / DETAILS

EXTERIOR ELEVATIONS / BLDG. SECTION

HVAC / ELECTRICAL PLANS

### PROJECT INFORMATION

ALL WORK SHALL CONFORM TO ALL YAVAPAI COUNTY ADOPTED CODES, ORDINANCES AND POLICIES INCLUDING BUT NOT LIMITED TO THE FOLLOWING:

2018 INTERNATIONAL PLUMBING CODE (IPC) 2018 INTERNATIONAL MECHANICAL CODE (IMC) 2017 NATIONAL ELECTRIC CODE (NEC) 2006 INTERNATIONAL ENERGY CONSERVATION CODE (IECC)

TRUSS CALCULATIONS

TO BE ON SITE AT TIME

LIVABLE: 787 SQ. FT. CARPORT/ALT. GARAGE: 400 SQ. FT

33 SQ. FT. TOTAL UNDER ROOF: 1,220 SQ. FT

OCCUPANCY: R-3 (Single-Family Residential) TYPE V-B CONSTRUCTION / NON-SPRINKLERED

### **GENERAL NOTES**

EXPENSE OF THE SAME.

FULLY SHIELDED FIXTURES ARE

1. DUE TO REPROGRAPHIC PROCESS, THESE PLANS MAY NOT BE ACCURATE TO SCALE. DIMENSIONS ARE NOT TO BE SCALED FROM THE WORKING DRAWINGS.

2. BEFORE ORDERING ANY MATERIALS OR STARTING ANY WORK, CONTRACTORS SHALL VERIFY ALL MEASUREMENTS AND EXISTING CONDITIONS AT THE SITE AND SHALL BE RESPONSIBLE FOR THE CORRECTNESS OF THE SAME. ANY DEVIATION AND/OR UNSAFE OR UNREGULATED CONDITIONS SHALL BE BROUGHT TO THE ATTENTION OF YAVAPAI COUNTY DEVELOPMENT SERVICES

3. GENERAL CONTRACTOR TO VERIFY AND LOCATE ALL UTILITY STUB OUTS AND MAINS BEFORE BEGINNING CONSTRUCTION OF PROJECT.

4. GENERAL CONTRACTOR TO VERIFY THE REMOVAL AND/OR REPLANTING OF LANDSCAPE IF THE CONDITION OCCURS OVER THE PROJECT SITE. 5. DAMAGE TO SITE, UTILITIES, OR NEWLY BUILT IMPROVEMENTS, NOT DESIGNED FOR REMOVAL, SHALL BE THE RESPONSIBLITY OF THE GENERAL CONTRACTOR INVOLVED, AND SHALL BE REPAIRED OR REPLACED AT THE

6. VERIFY UNIFORMITY OF ALL FRAMING SO AS TO CREATE A SMOOTH REGULAR FINISH WITH NO IRREGULARITIES.

7. IT IS THE RESPONSIBILTY OF THE GENRAL CONTRACTOR, TO THOROUGHLY REVIEW THE PLANS AND TO NOTIFY YAYAPAI COUNTY DEVELOPMENT SERVICES OF ANY DISCREPANCIES. YAVAPAI COUNTY, NOR THE ARCHITECT-OF-RECORD, WILL NOT BE RESPONSIBLE FOR MATERIALS IMPROPERLY ORDERED OR INSTALLED

8. FAILURE BY THE GENERAL CONTRACTOR, OR SUB-CONTRACTORS, TO AQUAINT THEM-SELVES WITH ALL AVAILABLE INFORMATION CONCERNING THIS PROJECT SHALL NOT RELIEVE THEM OF THE RESPONSIBILITY TO PERFORM THEIR

9. APPROVAL OF ALL CONSTRUCTION IS SUBJECT TO FIELD VERIFICATION

BY YAVAPAI COUNTY PERSONELL. 10. EVERY SLEEPING ROOM SHALL HAVE AT LEAST ONE (1) OPERATING WINDOW, OR DOOR, FOR EMERGENCY EGRESS, OPEN DIRECTLY TO A STREET, ALLEY, OR YARD.

RAIN GUTTERS / DRAINAGE EFFECTIVE APRIL 20, 2006 Rainwater from roofs and storm water from paved areas,

yards, courts and courtyards shall drain to an approved

place of disposal. (1101.2 2018 IPC) Drainage away from

structure shall be determined by Geotechnical Report.

SPECIAL INSPECTION REQUIRED Reports to be supplied to **Building Inspector** 

NO SCALE

PER IRC FIGURE R301. CAUTION avapai County permitted building plans do not relieve the Owner or General Contractor from their responsibilities to conform to al adopted building codes. Every effort has been made to provide a thorough plan review, however plans may contain irregularities. Owner/General Contractor Shall Not proceed with the project until the issue has been resolved through Yavapai County and any professional involved in the project

PLUMBING FIXTURE CLEARANCES

24 IN. CLEARANCE IN FRONT OF OPENING

Yavapai County Ordinance, Section 112.6 Drainage across Property Lines. Drainage across property lines shall not exceed that which existed prior to grading. Excess or concentrated drainage shall be contained on site or directed to an approved drainage facility. Erosion of the ground in the area of discharge shall be prevented by installation of non-erosive down-drains or other devices.

### FLOOR PLAN DOOR SCHEDULE DR. SIZE REMARKS # W. 101 | 3'-0" 6'-8" 1-3/4" EXTERIOR 6-PANEL SOLID-CORE WOOD 102 | 2'-8" SELF-CLOSING & SELF-LATCHING PROVIDE THRESHOLD AND 6'-8" 1-3/4" 2-PANEL SOLID-CORE WOOD W/ TEMPERED GLASS VISION PANEL WEATHERSTRIPPING 103 | 2'-8" 6'-8" 1-3/8" INTERIOR 4-PANEL HOLLOW CORE 104 | 5'-0" 6'-8" 1-3/8" **INTERIOR 4-PANEL SLIDING BI-PASS** 105 | 2'-4" 6'-8" 1-3/8" INTERIOR 4-PANEL SLIDING POCKET DOOR 6'-8" 106 | 3'-0" 1-1/8" INTERIOR 4-PANEL HOLLOW CORE 6'-8" 107 | 2'-4" 1-3/8" INTERIOR 4-PANEL SLIDING POCKET DOOR 108 | 5'-0" 6'-8" 1-3/8" **INTERIOR 4-PANEL SLIDING BI-PASS** 1-3/8" 109 | 2'-8" 6'-8" INTERIOR 4-PANEL SOLID CORE 1-3/8" 6'-8" 110 | 2'-0" INTERIOR 4-PANEL SOLID CORE FULL LOUVERED DOOR IS USING A GAS WATER HEATER SELF-CLOSING & SELF-LATCHING PROVIDE THRESHOLD AND 1-3/8" 111 | 2'-8" 6'-8" 4-PANEL SOLID CORE FROM GARAGE WEATHERSTRIPPING 4'-0"

SLIDER SLIDER SLIDER **TEMPERED GLASS** WINDOWS SHALL BE VINYL FRAME MAX. U-FACTOR: 0.40 (OPTION TO ELIMINATE FOUNDATION ÍNSULATION IF USING 0.32 OR BELOW U-FACTOR)

**HORIZONTAL** 

HORIZONTAL

WINDOW TYPES SCALE: 1/4" = 1'-0"

HORIZONTAL

SLIDER

**TEMPERED** 

GLASS

NOTE: FENESTRATION IN ZONE 2 (ELEVATIONS BELOW 3500 FT.) SHALL HAVE A MAXIMUM U-FACTOR OF 0.75. AND A MAXIMUM FENESTRATION SHGC FACTOR OF 0.40. FENESTRATION IN ZONE 4 (ELEVATIONS 3500 FT. AND ABOVE) SHALL HAVE A MAXIMU U-FACTOR OF 0.40. THE SHGC FACTOR IN ZONE 4 IS NOT APPLICABLE.

HORIZONTAL

24'-4"

22" × 30 ATTIC

ACCESS

24'-4"

10'-10"

BEDROOM #2

BATH #2

BEDROOM #1

11' = 2"

KITCHEN RANGE U ABOVE-

EATING AREA

COVERED ENTRY

5'-0"



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rensions and conditions shown hereon and at report to the Architect any error, inconsis

JLES BATH CT INFO OPENING 2 BEDROC

SHEET NO:

### PROPERTY OF YAVAPAI COUNTY. AZ

SCALE: 1/4" = 1'-0"

PROPERTY OF YAVAPAI COUNTY. AZ

PROPERTY OF YAVAPAI COUNTY, AZ

1" RIGID INSULATION

EFFECTIVE APRIL 20, 2006

ARC-FAULT CIRCUIT

ON EACH FLOOR LEVEL.

- SMOKE DETECTOR / CARBON MONOXIDE COMBO -CABLE TY OUTLET -CEILING FAN W/ LIGHT KIT

- SMOKE DETECTOR

- DOORBELL BUTTON → TELEPHONE OUTLET

### **ENERGY NOTES:**

### 1. WINDOWS DOOR & SKYLIGHTS

\*FENESTRATION U-FACTOR WINDOW AND DOORS TO BE .40 STICKER SHALL REMAIN ON WINDOWS, SKYLIGHTS & DOORS UNTIL INSPECTED AND APPROVED FOR THE ABOVE REQUIREMENT. THE FOUNDATION SLAB INSULATION MAY BE ELIMINATED IF USING A MAX. 0.32 U-FACTOR ON GLAZING.

### 2. CEILINGS

\* CEILING INSULATION TO BE MIN. R-30 (ZONE 2) + R-38 (ZONE 4) MARKERS SHALL BE AFFIXED TO THE TRUSSES OR JOIST AND MARKED WITH THE MIN. ISTALLED THICKNESS BY ONE INCH HIGH NUMBERS. A MIN. OF ONE MARKER SHALL BE INSTALLED FOR EVERY 300 SQ. FT. OF AREA WITH NUMBERS TO FACE THE ATTIC ACCESS OPENING. MARKERS MUST BE INSTALLED AT ROUGH IN OR WALL INSULATION INSPECTIONS.

3. WOOD FRAMED EXTERIOR WALLS (MIN. R-19 FOR 2 × 6 WALLS) \* WALL INSULATION SHALL BE IN SUBSTANTIAL CONTACT WITH THE SURFACE BEING INSULATED TO AVOID AIR PATHS THAT BYPASS THE INSULATION.

\* INSULATION SHALL NOT BE COMPRESSED BY INSET STAPLING OF THE BATT INSULATION OR OTHER MEANS \* INSULATION SHALL FILL ALL CAYATIES COMPLETLY BY CUTTING INSULATION AROUND ELECTRCAL OUTLETS AND SWITCHES AND BY SLICING INSULATION TO FIT BEHIND AND IN FRONT OF ELECTRICAL WIRING IN THE CAVITY AND PLUMBING PIPING \* BAND JOISTS AND OTHER INTERSTITIAL FLOOR ELEMENTS OF THE WALL SHALL BE INSULATED

### 4. NOT USED.

EXTERIOR OF

BUILDING

5. BUILDING THERMAL ENVELOPE

THE SEALING METHODS BETWEEN DISSIMILAR MATERAILS SHALL ALLOW FOR DIFFERENTAIL EXPANSION AND CONTRACTION. THE FOLLOWING SHALL BE CAULKED, GASKETED WEATHER STRIPPED OR OTHERWISE SEALED WITH AN AIR BARRIER MATERIAL, SUITABLE FILM OR SOLID MATERIAL

### ELECTRICAL GENERAL NOTES

1. ALL WORKMANSHIP, MATERIALS, AND METHODS SHALL CONFORM TO N.E.C. - 2017 EDITION.

2. ALL HABITABLE ROOMS SHALL BE PROVIDED W/ ELECTRICAL OUTLETS SO THAT NO PART OF THE WALL IS MORE THAN 6' FROM AN OUTLET. WALL SECTIONS 2' OR LARGER & KITCHEN COUNTERS WIDER THAN 12" SHALL BE SERVICED BY A RECEPTACLE.

3. ALL RECEPTICALS IN BATHROOMS, OUTSIDE & WITHIN 6' OF WATER SOURCE SHALL BE G.F.C.I.

4. ALL SMOKE DETECTORS SHALL BE INTERCONNECTED ON SEPARATE CIRCUIT & SHALL RECEIVE PRIMARY POWER FROM BUILDING WIRING & SHALL HAVE BATTERY BACKUP. CONNECT NEW SMOKE DETECTORS TO NEW AUDIBLE SYSTEM INSIDE EXISTING RESIDENCE.

5. LIGHTS IN CLOSETS SHALL BE 18" FROM SHELVING (MEASURED HORZTL. OR BE RECESSED.

6. PROVIDE MINIMUM TWO 2014 BRANCH CIRCUITS FOR RECEPTACLES LOCATED IN THE KITCHEN, PANTRY, EATING AREA, A SEPARATE 20A BRANCH CIRCUIT TO THE LAUNDRY EQUIP., AND A SEPARATE 20A BRANCH CIRCUIT FOR BATHROOM RECEPTACLES.

ALL BRANCH CIRCUITS THAT SUPPLY 120-VOLT SINGLE PHASE 15 & 20 AMP OUTLETS INSTALLED IN FAMILY ROOMS, DINING ROOMS LIVING ROOMS, PARLORS, LIBRARIES, DENS, BEDROOMS, SUNROOMS RECREATION ROOMS, CLOSETS, HALLWAYS AND SIMILAR ROOMS OR AREAS SHALL BE PROTECTED BY COMBINATION TYPE ARC FAULT CURCUIT INTERUPTERS INSTALLED TO PROVIDE PROTECTION OF THE

8. FIXTURES, FITTINGS, BOXES AND RECEPTACLES LOCATED IN DAMP OR WET LOCATIONS SHALL BE 'LISTED' TO BE SUITABLE FOR SUCH CONDITIONS.

9. CONTRACTOR TO EMBED 20' OF #4 AWG COPPER WIRE IN FOOTING FOR ELECTRICAL SERVICE GROUND, PROVIDE BONDING TO THE INTERIOR WATER PIPING AND ABOVE GROUND PORTION OF GAS PIPING SYSTEM

10. IN KITCHEN AND DINING ROOMS A RECEPTACLE OUTLET SHALL BE INSTALLED AT EACH WALL COUNTER SPACE 12' OR WIDER SO THAT AT NO POINT ALONG THE WALL IS MORE THAN 24" FROM A RECEPTACLE OUTLET AND SHALL BE GFCI PROTECTED.

11. PROVIDE AT LEAST ONE WEATHER PROOF RECEPTACLE OUTLET NOT MORE THAN 6'-6" ABOVE GRADE AND GFCI PROTECTED. AT THE FRONT AND BACK OF EACH DWELLING, ALL RECEPTACLES INSTALLED OUTDOORS MUST BE GFCI PROTECTED.

12. ALL EXTERIOR LIGHTING SHALL CONFORM TO YAVAPAI COUNTY DARK SKY ORDINANCE.

13. IN ATTICS, A SERVICE OUTLET & LIGHTING FIXTURE LOCATED NEAR THE APPLIANCE REQUIRING SERVICE SHALL BE CONTROLLED BY A SWITCH AT THE ENTRY OF THE ATTIC. (REQUIRED FOR ATTIC MOUNT FURNACES)

A. ALL JOINTS, SEAMS AND PENETRATIONS. B. SITE BUILT WINDOWS, DOORS AND SKYLIGHTS C. OPENINGS BETWEEN WINDO AND DOOR ASSEMBLIES AND THEIR RESPECTIVE JAMBS AND FRAMING. D. UTILITY PENETRATIONS.

E. DROPPED CEILINGS OR CHASES ADJACENT TO THE THERMAL ENVELOPE. F. KNEE WALLS

G. WALLS AND CEILINGS SEPERATING GARAGE FROM CONDITIONED SPACES. H. BEHIND TUB AND SHOWERS ON EXTERIOR WALLS

COMMEN WALLS BETWEEN DWELLING UNITS J. OTHER SOURCES OF INFILTRATION.

### 6. FENESTRATION AIR LEAKAGE

\* WINDOW, SKYLIGHT AND SLIDING GLASS DOOR SHALL HAVE AN AIR INFILTRATION RATE OF NO MORE THAN 0.3 CFM PER SQUARE FOOT, AND SINGING DOORS NO MORE THAN 0.5 CFM. SPECIFICATIONS SHALL BE LISTED ON THE MANUF. LABEL. (USE TYVEK HOUSE WRAP, INSTALL PER MANUF. SPECS)

### 7. RECESSED LIGHTING

RECESSED LUMINAIRES INSTALLED IN THE BUILDING THERMAL ENEVELOPE SHALL BE SEALED TO LIMIT AIR LEAKAGE BETWEEN CONDITIONED AND UNCONDITIONED SPACES BY

A. IC RATED AND LABELED WITH ENCLOSURES THAT ARE SEALED OR GASKETED TO PREVENT AIR LEAKAGE TO CEILING CAVITY OR UNCONDITIONED SPACE OR B. IC RATED AND LABELED AS MEETING ASTM E 283 OR C. LOCATED INSIDE AIRTIGHT SEALED BOX WITH CLEARANCES OF AT LEAST 0.5 INCH FROM COMBUSTIBLE MATERIAL AND

### 8. HEAT PUMP SUPPLEMENTARY HEAT

3 INCHEDS FROM INSULATION.

\* HEAT PUMPS HAVING SUPPLEMENTARY ELECTRIC - RESISTANCE HEAT SHALL HAVE CONTROLS THAT, EXCEPT DURING DEFROST PREVENT SUPPLEMENTAL HEAT OPERATION WHIN THE HEAT PUMP COMPRESSOR CAN MEET THE HEATING LOAD.

\* AT LEAST ONE THERMOSTAT SHALL BE PROVIDED FOR EACH SEPERATE HEATING & COOLING SYSTEM.

INSULATE ALL HOT WATER PIPING WITH MINIMUM R-3 INSULATION

DIELECTRIC UNION (TYPICAL)

WATER HEATER -

PROVIDE SQUARE 3" DEEP
GALVANIZED STEEL DRAIN PAN
WITH ALL SEAMS WATER TICHT.
PROVIDE 3/4" DRAIN PIPE
CONNECTION TO PAN. PIPE DRAIN
PAN LINE & P. & T. RELIEF DRAIN
LINE INDEPENDANTLY TO TERMINATE
AS NOTED ON PLANS.

10. DUCT INSULATION \* SUPPLY AND RETURN DUCTS SHALL BE INSULATED TO A MIN. OF R-8 (EXCEPT DUCTS THAT COMPLETLY INSIDE THE BUILDING THERMAL ENVELOPE.)

\* ALL DUCTS, AIR HANDLERS, FILTER BOXES, AND BUILDING CAVITIES (NOT FOR AIR SUPPLY) USED AS DUCTS SHALL BE SEALED. JOINTS AND SEAMS SHALL COMPLY WITH SECTION M1601.3.1 OF THE IRC.

12. MECHANICAL SYSTEM PIPING INSULATION \* MECHANICAL SYSTEM PIPING CAPABLE OF CARRYING FLUIDS ABOYE 105 D. F OR BELOW 55 D. F SHALL BE INSULATED TO

### 13. CIRCULATING HOT WATER SYSTEMS

\* ALL CIRCULATING SERVICE HOT WATER PIPING SHALL BE INSULATED TO AT LEAST R-2. ALL NEW RESIDENCES WITH 2 OR MORE BATHROOMS SHALL HAVE A CIRCULATING HOT WATER SYSTEM. CHWS SHALL INCLUDE AN AUTOMATIC OR READILY ACCESSIBLE MANUAL SWITCH THAT CAN TURN OFF THE HUCP WHEN THE SYSTEM IS NOT IN USE. THERMAL SIPHONING SYSTEMS SHALL HAVE A VALVE TO REDUCE FLOW. ALTERNATE SYSTEM SHALL BE CONSIDERED.


14. MECHANICAL VENTIALTION \*OUTDOOR AIR INTAKES AND EXHAUST SHALL HAVE AUTOMATIC GRAVITY DAMPER THAT CLOSE WHEN THE VENTILATION SYSTEM IS NOT OPERATING.

15. EQUIPTMENT SIZING \*HEATING & COOLING EQUIPTMENT SHALL BE SIZED IN ACCORDANCE WITH SECTION M1401.3 OF THE IRC.

### 16. AIR LEAKAGE

AIR FLOW RETARDERS (HOUSE WRAPS) MUST BE: A. IMPERMEABLE TO AIR FLOW. B. CONTINOUS OVER THE ENTIRE BUILDING ENVELOPE C. ABLE TO WITHSTAND THE FORCES THAT MAY ACT ON IT DURING AND AFTER CONSTRUCTION.

D. DURABLE OVER THE EXPECTED LIFETIME OF THE BUILDING. E. ALL SEAMS AND EDGES MUST BE SEALED/TAPED PER MANUF SPECIFICATIONS

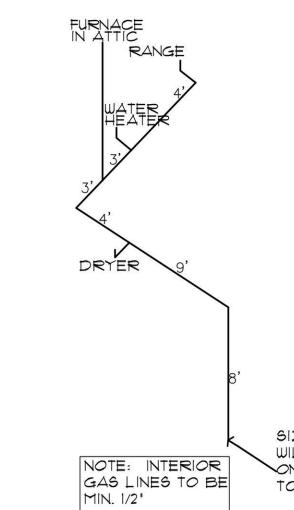


SCALE: 1/4" = 1'-0" SIZE OF INCOMING WILL BE BASED ON DISTANCE TO GAS SOURCE. GAS PIPING ISOMETRIC


SUPPLY-AIR GRILL

RETURN AIR GRILL

THERMOSTAT

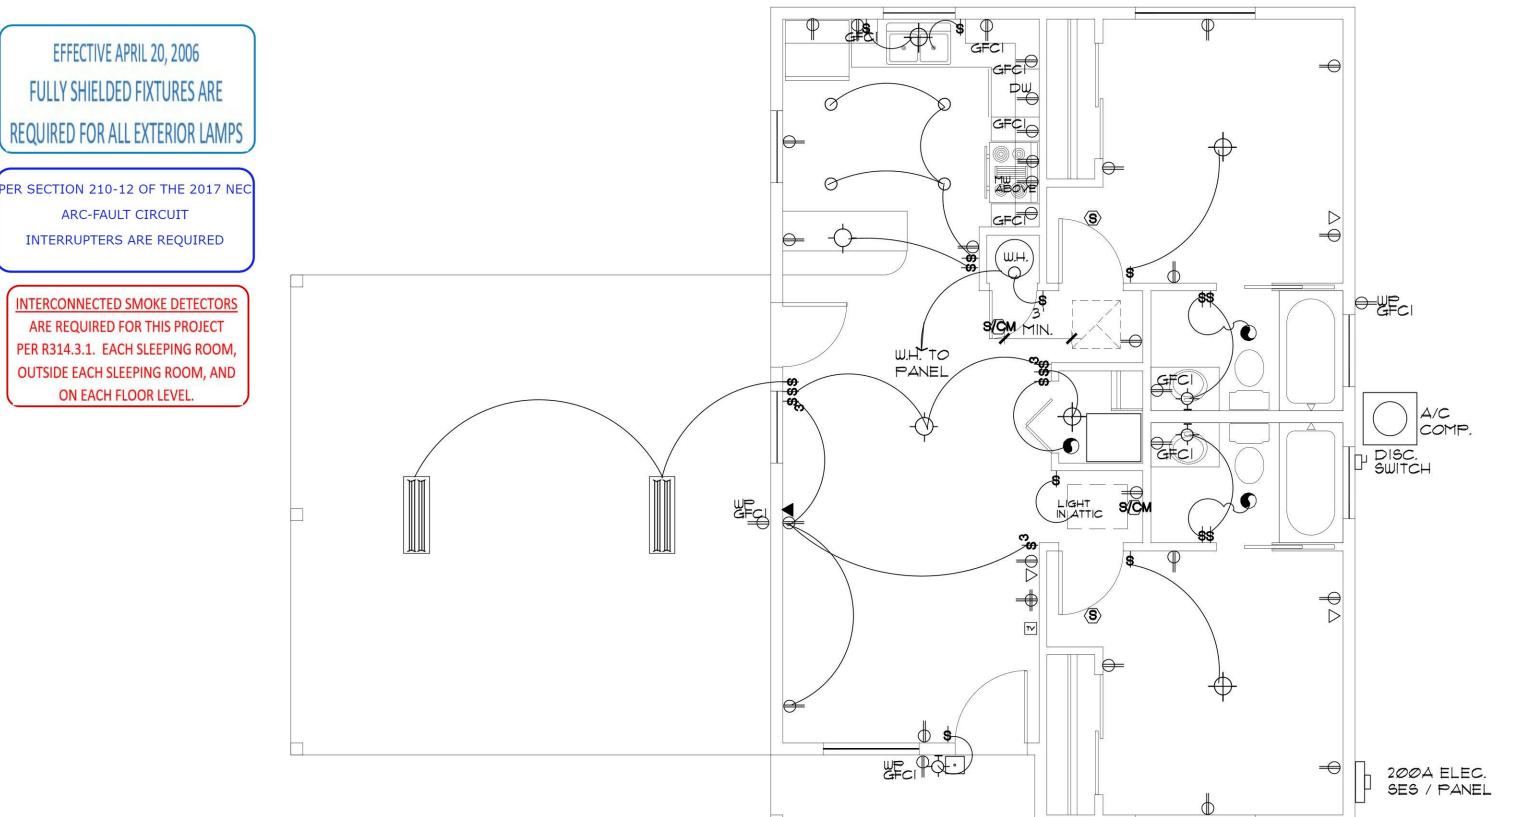



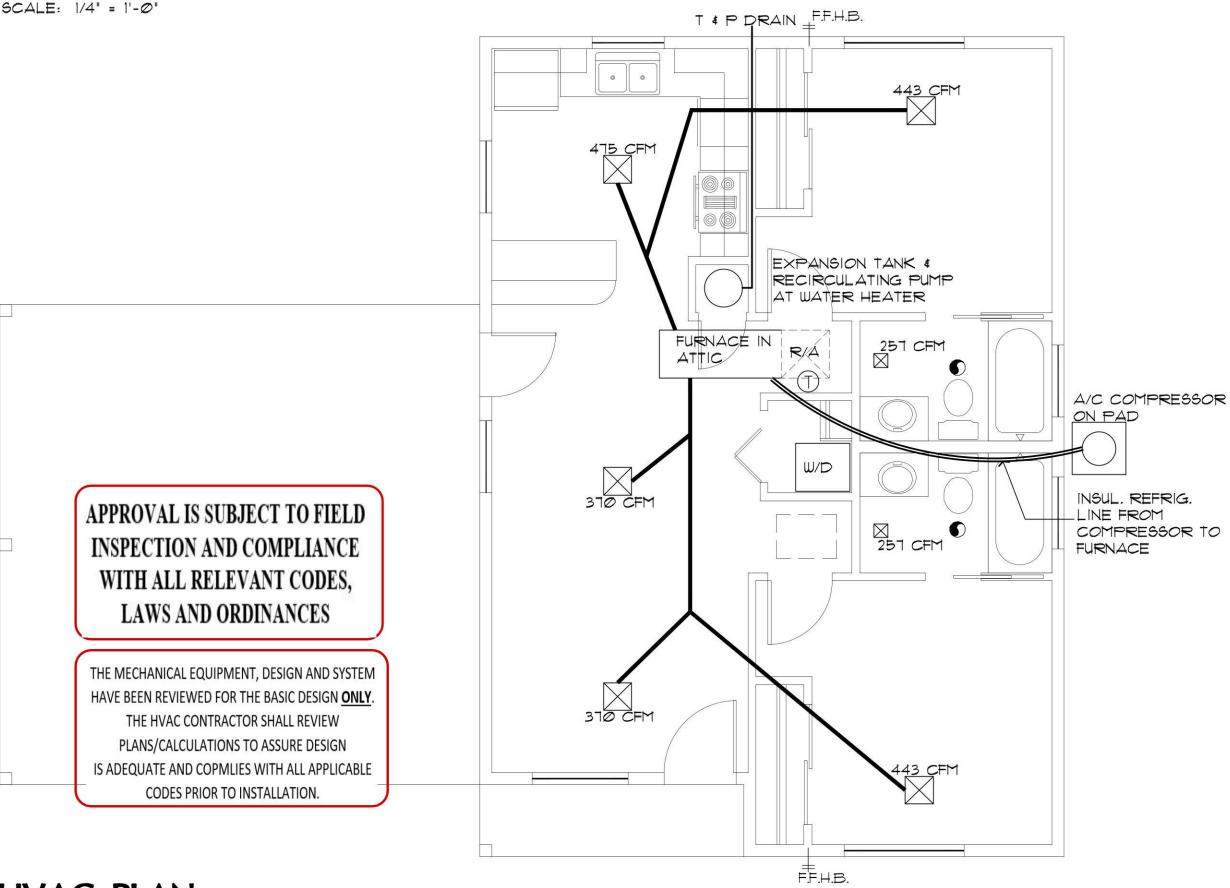

### **HVAC PLAN**

SIZING, DUCT SIZING, AND DUCT LAYOUT PRIOR TO INSTALLATION.

2. DRAIN AND VENT SIZES TO BE DETERMINED BY PLUMBING CONTRACTOR. 3. WATER HEATER RELIEF VALVE SHALL EXTEND OUTSIDE OF THE BUILDING WITH THE END OF THE PIPE NOT MORE THAN 2' NOR LESS THAN 6' ABOVE THE GROUND AND POINTING DOWNWARD.

1. THE MECHANICAL CONTRACTOR SHALL DETERMINE THE FINAL EQUIPMENT

4. PROVIDE A PAN, AND DRAIN FOR THE WATER HEATER.

**HVAC GENERAL NOTES:** 

5. THE CLOTHES DRYER EXHAUST DUCT SHALL BE AT LEAST THE DIAMETER OF THE APPLIANCE OUTLET AS RECOMMENDED BY THE MANUFACTURER AND SHALL TERMINATE AT THE EXTERIOR OF THE BUILDING. IT SHALL NOT EXCEED 25' IN LENGTH WITH REDUCTIONS FOR BENDS. THE DUCT SHALL TERMINATE NOT LESS THAN 3' FROM A PROPERTY LINE.

# ANS OTES

ARIZ ŽΚ

12/09/2020

AS NOTED

MFR

MFR

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dimensions and conditions shown hereon and at

once report to the Architect any error, inconsis-

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MARK F ROGERS \

tancy or omission he may discover.

It is to be returned upon request.

Date

Scale

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Drawn by

Chk'd by:

Revisions:

**AB.** 7 >

REVIEWED FOR DESIGN CRITERIA SHEET NO: ONLY ME-

TRICAL OL SC BEDRC

# ELECTRIC WATER HEATER DETAIL

**√**⊕-□

TO EXTERIOR

-GALV. DRAIN PAN

T&P FULL-SIZE RELIEF LINE

EXPANSION TANK (PROVIDE SUPPORT

— S.O.V., (TYP)

- UNION, TYPE

- CHECK VALVE TYP.

- HOT WATER RETURN

NOTE: DRAIN PAN, AND T&P

MUST DRAIN BY GRAVITY. WATER

HEATER SHALL BE HIGH ENOUGH

OFF THE FLOOR TO PROVIDE FOR

DISCHARGE PIPING TO EXTERIOR.

GAS WATER HEATER OPTION

PROPERTY OF YAVAPAI COUNTY, AZ